DRY LAND APPROVED JURISDICTIONAL DETERMINATION FORM¹ **U.S. Army Corps of Engineers**

This form should be completed by following the instructions provided in Section IV of the JD Form Instructional Guidebook.

SECTION I: BACKGROUND INFORMATION

- A. REPORT COMPLETION DATE FOR APPROVED JURISDICTIONAL DETERMINATION (JD):

B. DISTRICT OFFICE, FILE NAME, AND NUMBER: Albuquerque District, Will Ruth Pond and Conveyance Improvements Project, SPA-2022-00296		
C. PROJE		DJECT LOCATION AND BACKGROUND INFORMATION:
		e: TX County/parish/borough: El Paso County City: ter coordinates of site (lat/long in degree decimal format): Lat. 31.88538°, Long106.566735° Universal Transverse Mercator: 351821.48 W, 3528801.36 N, Zone 13
		ne of nearest waterbody: Grande, Rio ne of watershed or Hydrologic Unit Code (HUC): El Paso-Las Cruces 13030102
	V	Check if map/diagram of review area is available upon request.
		Check if other sites (e.g., offsite mitigation sites, disposal sites, etc) are associated with this action and are recorded on a different JD form.
D.	REVIEW PERFORMED FOR SITE EVALUATION (CHECK ALL THAT APPLY):	
	~	Office (Desk) Determination. Date:8/10/2022
		Field Determination. Date(s):
SEC	CTIO	N II: SUMMARY OF FINDINGS
		SECTION 10 DETERMINATION OF JURISDICTION.
There are no "navigable waters of the U.S." within Rivers and Harbors Act (RHA) jurisdiction (as defined by 33 CFR part 329) in the review area.		
В.	CWA	SECTION 404 DETERMINATION OF JURISDICTION.
The	ere ar	e no "waters of the U.S." within Clean Water Act (CWA) jurisdiction (as defined by 33 CFR part 328) in the review area.
		N III: DATA SOURCES.
A.	requ	PORTING DATA. Data reviewed for JD (check all that apply - checked items shall be included in case file and, where checked and tested, appropriately reference sources below): Maps, plans, plots or plat submitted by or on behalf of the applicant/consultant:
		Data sheets prepared/submitted by or on behalf of the applicant/consultant.
		Office concurs with data sheets/delineation report.
		Office does not concur with data sheets/delineation report.
		Data sheets prepared by the Corps:
		U.S. Geological Survey Hydrologic Atlas: Rio Grande Region
		USGS NHD data.

USGS 8 and 12 digit HUC maps. ▼ U.S. Geological Survey map(s). Cite scale & quad name: 1:24K; Canutillo USDA Natural Resources Conservation Service Soil Survey. Citation:

National wetlands inventory map(s). Cite name: Canutillo

State/Local wetland inventory map(s):

FEMA/FIRM maps:

[7] 100-year Floodplain Elevation is: (National Geodectic Vertical Datum of 1929)

Photographs: Aerial (Name & Date): or Other (Name & Date):

Previous determination(s). File no. and date of response letter:

Applicable/supporting case law:


Applicable/supporting scientific literature:

Other information (please specify):

B. REOUIRED ADDITIONAL COMMENTS TO SUPPORT JD. EXPLAIN RATIONALE FOR DETERMINATION THAT THE REVIEW AREA ONLY INCLUDES DRY LAND:

The review area is if within the city of El Paso Texas, surrounded by residential development. There are no potential waters on the site, the area is comprised entirely of uplands.

¹ This form is for use only in recording approved JDs involving dry land. It extracts the relevant elements of the longer approved JD form in use since 2007 for aquatic areas and adds no new fields.

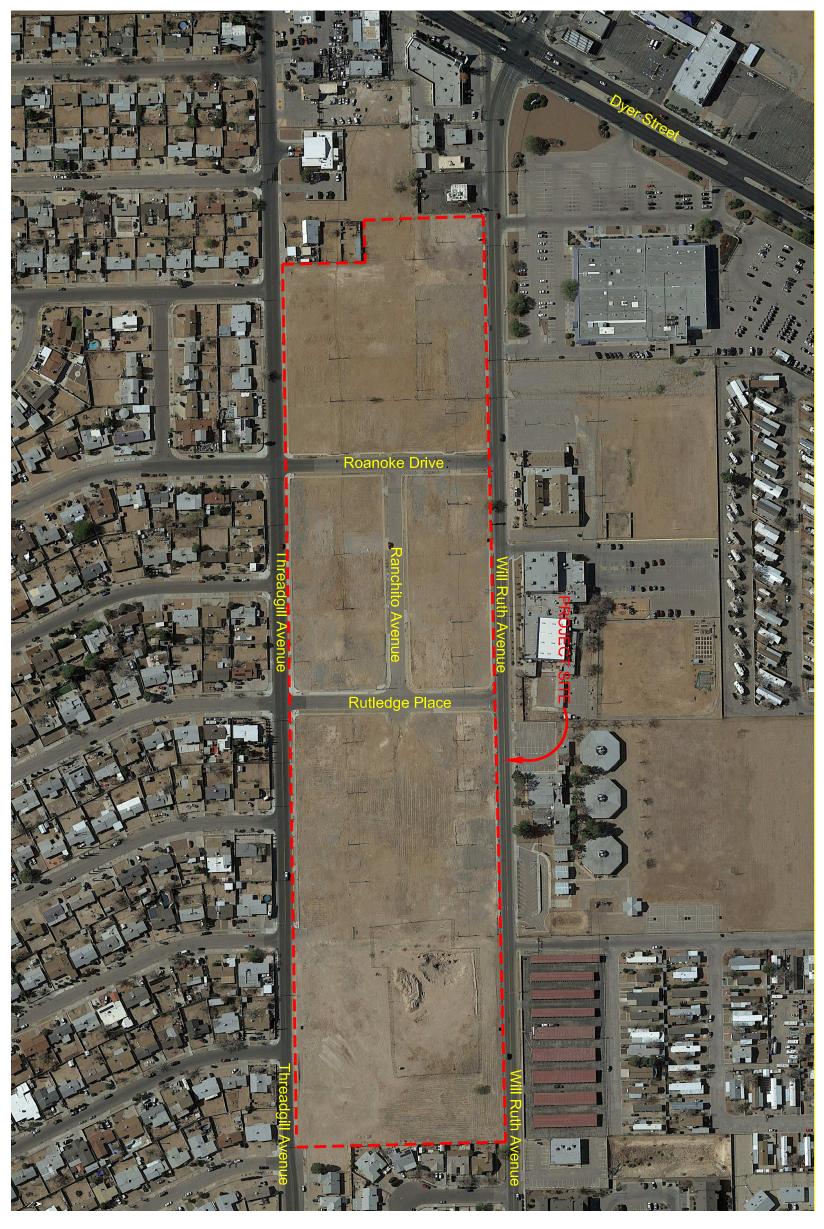

LEGEND
PROJECT SITE

SCALE: NTS
FIGURE IS FOR GRAPHICAL
REPRESENTATION ONLY.

SCALE: NTS

Sheet No.

Environmental Information Document Will Ruth Pond El Paso TX, 79924

Site Plan



Project No.

EPW 22-04

Date: May 2022


Scale: NTS

dwg by: ESSCO

designed by:
ESSCO

PHOTOGRAPHIC REPORTING DATA SHEET

Photograph No. 1

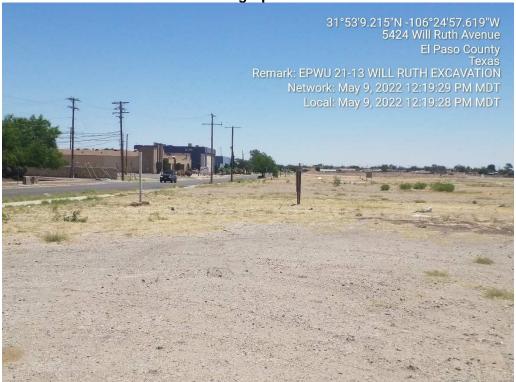

View looking east, depicting graded surface of western portion of Project Site.

Photograph No. 2



View showing depicting graded surface of western portion of Project Site.